SITE NAME:

BRIDGER SKI HILL

PROJECT DESCRIPTION: PROPOSED TELECOMMUNICATIONS

FACILITY

TOWER TYPE:

70' MONOPINE

SITE ADDRESS:

XXX BRIDGER BOWL ROAD

(E911 ADDRESS TBD)

BOZEMAN, MT 59715 (GALLATIN COUNTY)

ZONING JURISDICTION:

GALLATIN COUNTY

AREA OF

2,500 ± SQ. FT. (LEASE AREA)

CONSTRUCTION: LEGAL DESCRIPTION:

NE ¼, S30, T1N, R7E

PRESENT

OCCUPANCY TYPE:

SKI AREA

GEOCODE:

06-1013-29-3-02-02-0000

ZONING:

B-4-BASE AREA

RECREATIONAL & FORESTRY

PROJECT INFORMATION

LATITUDE: LONGITUDE:

N 45° 48' 55.82" (NAD 83) * W 110° 53' 36.12" (NAD 83)

GROUND ELEVATION:

6116' (NAVD 88) '

* INFORMATION PROVIDED BY WWC ENGINEERING IN THE FORM OF A SURVEY.

USA · INTERNATIONAL



SITE NAME: **BRIDGER SKI HILL**

XXX BRIDGER BOWL ROAD **BOZEMAN, MT 59715** (GALLATIN COUNTY)

CALL FOR UNDERGROUND UTILITIES PRIOR TO DIGGING

(800) 424-5555

CALL 911



ALL WORK AND MATERIALS SHALL BE PERFORMED AND INSTALLED IN ACCORDANCE WITH THE CURRENT EDITIONS OF THE FOLLOWING CODES AS ADOPTED BY THE LOCAL GOVERNING AUTHORITIES, NOTHING IN THESE PLANS IS TO BE CONSTRUED TO PERMIT WORK NOT CONFORMING TO THE ATEST EDITIONS OF THE FOLLOWING:

- INTERNATIONAL BUILDING CODE 4. (2012 EDITION) INTERNAL CODE COUNCIL
- NATIONAL ELECTRIC CODE (2014 EDITION) LOCAL BUILDING CODE

NORTHWESTERN ENERGY

- ANSI/TIA/EIA-222-G

- FACILITY DESIGNED IN ACCORDANCE WITH THE GALLATIN COUNTY REGULATIONS.
 THIS IS AN UNMANNED FACILITY WHICH WILL NOT REQUIRE ANY WATER OR SEWER FACILITIES.
 TRAFFIC WILL CONSIST ONLY OF MAINTENANCE PERSONNEL, VISITING THE SITE

INDEX OF SHEETS

CONSTRUCTION OF A TELECOMMUNICATION FACILITY, CONSISTING OF ANTENNAS & ASSOCIATED APPURTENANCES ON A PROPOSED MONOPINE, FENCED COMPOUND & SERVICE EQUIPMENT FOR FUTURE CARRIERS. NO WATER OR

CODE COMPLIANCE

TOWER COORDINATES



LOCATION MAP

FROM BOZEMAN, MT HEAD NORTH ONTO MT-86 N/BRIDGER DR/ BRIDGER CANYON DR FRUM BUZEMAN, MI FIREM NOKITI ONTO MI-90 INDRIDGER ON BRIDGER CANTON DE FOR 14.3 MILES. TURN LEFT ONTO BRIDGER BOWL RD. IN 0.7 MILES, THE SITE WILL BE ON THE LEFT IN THE BRIDGER BOWL SKI AREA PARKING LOT.

SITE CONSTRUCTION MANAGER:

NAME: CONTACT:

WIBLUE, INC. CALEB CROSSLAND (303) 448-8896

(303) 448-8896

SITE APPLICANT:

ATLAS 1, LLC 4450 ARAPAHOE AVE, SUITE 100 ADDRESS CITY, STATE, ZIP: BOULDER, CO 80303 CONTACT: CALEB CROSSLAND

ORIGINAL SURVEYOR:

WWC ENGINEERING NAME: 1275 MAPLE ST. SUITE F CITY, STATE, ZIP: HELENA, MT 59601 CONTACT: (406) 443-3962

CIVIL ENGINEER:

TOWER ENGINEERING PROFESSIONALS NAME: ADDRESS: CITY, STATE, ZIP: 326 TRYON ROAD

RALIEGH, NC 27603 GRAHAM M. ANDRES, P.E. (919) 661-6351

ELECTRICAL ENGINEER:

TOWER ENGINEERING PROFESSIONALS NAME: ADDRESS: 326 TRYON ROAD CITY, STATE, ZIP:

RALEIGH, NC 27603 GRAHAM M. ANDRES, P.E. (919) 661-6351

PROPERTY OWNER:

BRIDGER BOWL INC. NAME: 15795 BRIDGER CANYON RD **ADDRESS** CITY, STATE, ZIP: BOZEMAN, MT 59715

CONTACT INFORMATION

UTILITIES:

CONTACT:

POWER COMPANY:

121 E GRIFFIN DR BOZEMAN, MT 59715 CUSTOMER SERVICE (800) 586-1386

POLE # NEAR SITE:

TELEPHONE COMPANY: TBD

N/A N/A PHONE: N/A
PEDESTAL # NEAR SITE: TBD

APPROXIMATELY TWICE A MONTH. DATE PROJECT DESCRIPTION & NOTES DRAWN BY: CJV REV DESCRIPTION SHEET 3 TITLE SHEET T1 GENERAL NOTES N1 3 M1 VICINITY MAP I 3 VICINITY MAP II M2 3 VICINITY MAP III 3 SITE PLAN Z1 TOWER ELEVATION 3 COMPOUND DETAIL Z3 FENCE DETAILS **Z**4 SEAL:

REVISION: SHEET NUMBER:

PLANS PREPARED BY:

03-29-16

03-04-16

03-03-16

03-01-16

TOWER ENGINEERING PROFESSIONALS

5545 WEST 56TH AVE., UNIT E

ARVADA, CO 80002

OFFICE: (303) 566-9914

www.tepgroup.net

ZONING

ZONING

ZONING

ZONING

ISSUED FOR:

CHECKED BY:

TEP#: 31780.7028

DRIVING DIRECTIONS

GENERAL NOTES:

- ALL REFERENCES TO OWNER IN THESE DOCUMENTS SHALL BE CONSIDERED ATLAS TOWER HOLDINGS, LLC, OR ITS DESIGNATED REPRESENTATIVE.
- 2. ALL WORK PRESENTED ON THESE DRAWINGS MUST BE COMPLETED BY THE CONTRACTOR UNLESS NOTED OTHERWISE. THE CONTRACTOR MUST HAVE CONSIDERABLE EXPERIENCE IN PERFORMANCE OF WORK SIMILAR TO THAT DESCRIBED HEREIN. BY ACCEPTANCE OF THIS ASSIGNMENT, THE CONTRACTOR IS ATTESTING THAT HE DOES HAVE SUFFICIENT EXPERIENCE AND ABILITY, THAT HE IS KNOWLEDGABLE OF THE WORK TO BE PERFORMED AND THAT HE IS PROPERLY LICENSED AND PROPERLY REGISTERED TO DO THIS WORK IN THE STATE OF MONTANA.
- 3. STRUCTURE IS DESIGNED IN ACCORDANCE WITH ANSI/TIA/EIA-222-G, 2005, FOR A 90 MPH 3-SECOND GUST WIND LOAD. THIS CONFORMS TO THE REQUIREMENTS OF THE INTERNATIONAL BUILDING CODE, 2012 EDITION.
- 4. WORK SHALL BE COMPLETED IN ACCORDANCE WITH THE INTERNATIONAL BUILDING CODE, 2012 EDITION.
- 5. UNLESS SHOWN OR NOTED OTHERWISE ON THE CONTRACT DRAWINGS, OR IN THE SPECIFICATIONS, THE FOLLOWING NOTES SHALL APPLY TO THE MATERIALS LISTED HEREIN, AND TO THE PROCEDURES TO BE USED ON THIS PROJECT.
- ALL HARDWARE ASSEMBLY MANUFACTURER'S INSTRUCTIONS SHALL BE FOLLOWED EXACTLY AND SHALL SUPERCEDE ANY CONFLICTING NOTES ENCLOSED HEREIN.
- 7. IT IS THE CONTRACTOR'S SOLE RESPONSIBILITY TO DETERMINE ERECTION PROCEDURE AND SEQUENCE TO ENSURE THE SAFETY OF THE STRUCTURE AND IT'S COMPONENT PARTS DURING ERECTION AND/OR FIELD MODIFICATIONS. THIS INCLUDES, BUT IS NOT LIMITED TO, THE ADDITION OF TEMPORARY BRACING, GUYS OR TIE DOWNS THAT MAY BE NECESSARY. SUCH MATERIAL SHALL BE REMOVED AND SHALL REMAIN THE PROPERTY OF THE CONTRACTOR AFTER THE COMPLETION OF THE PROJECT.
- 8. ALL DIMENSIONS, ELEVATIONS, AND EXISTING CONDITIONS SHOWN ON THE DRAWINGS SHALL BE FIELD VERIFIED BY THE CONTRACTOR PRIOR TO BEGINNING ANY MATERIALS ORDERING, FABRICATION OR CONSTRUCTION WORK ON THIS PROJECT. CONTRACTOR SHALL NOT SCALE CONTRACT DRAWINGS IN LIEU OF FIELD VERIFICATIONS. ANY DISCREPANCIES SHALL BE IMMEDIATELY BROUGHT TO THE ATTENTION OF THE OWNER AND THE OWNER'S ENGINEER. THE DISCREPANCIES MUST BE RESOLVED BEFORE THE CONTRACTOR IS TO PROCEED WITH THE WORK, THE CONTRACT DOCUMENTS DO NOT INDICATE THE METHOD OF CONSTRUCTION. THE CONTRACTOR SHALL SUPERVISE AND DIRECT THE WORK AND SHALL BE SOLELY RESPONSIBLE FOR ALL CONSTRUCTION MEANS, METHODS, TECHNIQUES, SEQUENCES, AND PROCEDURES. OBSERVATION VISITS TO THE SITE BY THE OWNER AND/OR THE ENGINEER SHALL NOT INCLUDE INSPECTION OF THE PROTECTIVE MEASURES OR THE PROCEDURES.
- 9. ALL MATERIALS AND EQUIPMENT FURNISHED SHALL BE NEW AND OF GOOD QUALITY, FREE FROM FAULTS AND DEFECTS AND IN CONFORMANCE WITH THE CONTRACT DOCUMENTS. ANY AND ALL SUBSTITUTIONS MUST BE PROPERLY APPROVED AND AUTHORIZED IN WRITING BY THE OWNER AND ENGINEER PRIOR TO INSTALLATION. THE CONTRACTOR SHALL FURNISH SATISFACTORY EVIDENCE AS TO THE KIND AND QUALITY OF THE MATERIALS AND EQUIPMENT BEING SUBSTITUTED.
- 10. THE CONTRACTOR SHALL BE RESPONSIBLE FOR INITIATING, MAINTAINING, AND SUPERVISING ALL SAFETY PRECAUTIONS AND PROGRAMS IN CONNECTION WITH THE WORK. THE CONTRACTOR IS RESPONSIBLE FOR INSURING THAT THIS PROJECT AND RELATED WORK COMPLIES WITH ALL APPLICABLE LOCAL, STATE, AND FEDERAL SAFETY CODES AND REGULATIONS GOVERNING THIS WORK.
- 11. ACCESS TO THE PROPOSED WORK SITE MAY BE RESTRICTED. THE CONTRACTOR SHALL COORDINATE INTENDED CONSTRUCTION ACTIVITY, INCLUDING WORK SCHEDULE AND MATERIALS ACCESS, WITH THE RESIDENT LEASING AGENT FOR APPROVAL.
- 12. BILL OF MATERIALS AND PART NUMBERS LISTED ON CONSTRUCTION DRAWINGS ARE INTENDED TO AID CONTRACTOR. CONTRACTOR SHALL VERIFY PARTS AND QUANTITIES WITH MANUFACTURER PRIOR TO BIDDING AND/OR ORDERING MATERIALS.
- 13. ALL PERMITS THAT MUST BE OBTAINED ARE THE RESPONSIBILITY OF THE CONTRACTOR. THE CONTRACTOR WILL BE RESPONSIBLE FOR ABIDING BY ALL CONDITIONS AND REQUIREMENTS OF THE PERMITS.
- 14. 24 HOURS PRIOR TO THE BEGINNING OF ANY CONSTRUCTION, THE CONTRACTOR MUST NOTIFY THE APPLICABLE JURISDICTIONAL (STATE, COUNTY OR CITY) ENGINEER.
- 15. THE CONTRACTOR SHALL REWORK (DRY, SCARIFY, ETC.) ALL MATERIAL NOT SUITABLE FOR SUBGRADE IN ITS PRESENT STATE. AFTER REWORKING, IF THE MATERIAL REMAINS UNSUITABLE, THE CONTRACTOR SHALL UNDERCUT THIS MATERIAL AND REPLACE WITH APPROVED MATERIAL. ALL SUBGRADES SHALL BE PROOFROLLED WITH A FULLY LOADED TANDEM AXLE DUMP TRUCK PRIOR TO PAVING. ANY SOFTER MATERIAL SHALL BE REWORKED OR REPLACED.
- 16. THE CONTRACTOR IS REQUIRED TO MAINTAIN ALL PIPES, DITCHES, AND OTHER DRAINAGE STRUCTURES FREE FROM OBSTRUCTION UNTIL WORK IS ACCEPTED BY THE OWNER. THE CONTRACTOR IS RESPONSIBLE FOR ANY DAMAGES CAUSED BY FAILURE TO MAINTAIN DRAINAGE STRUCTURE IN OPERABLE CONDITION.
- 17. ALL MATERIALS AND WORKMANSHIP SHALL BE WARRANTED FOR ONE YEAR FROM ACCEPTANCE DATE.
- 18. ALL BUILDING DIMENSIONS SHALL BE VERIFIED WITH THE PLANS (LATEST REVISION) PRIOR TO COMMENCING CONSTRUCTION. NOTIFY THE ENGINEER IMMEDIATELY IF ANY DISCREPANCIES ARE DISCOVERED. THE OWNER SHALL HAVE A SET OF APPROVED PLANS AVAILABLE AT THE SITE AT ALL TIMES WHILE WORK IS BEING PERFORMED. A DESIGNATED RESPONSIBLE EMPLOYEE SHALL BE AVAILABLE FOR CONTACT BY GOVERNING AGENCY INSPECTORS.

STRUCTURAL STEEL NOTES:

- THE FABRICATION AND ERECTION OF STRUCTURAL STEEL SHALL CONFORM TO THE AISC SPECIFICATIONS AND MANUAL OF STEEL CONSTRUCTION, 14TH EDITION.
- 2. UNLESS OTHERWISE NOTED, ALL STRUCTURAL ELEMENTS SHALL CONFORM TO THE FOLLOWING REQUIREMENTS:
 - A. STRUCTURAL STEEL, ASTM DESIGNATION A36 OR A992 GR50.
 - B. ALL BOLTS, ASTM A325 TYPE I GALVANIZED HIGH STRENGTH BOLTS.
 - C. ALL NUTS, ASTM A563 CARBON AND ALLOY STEEL NUTS.
 - D. ALL WASHERS, ASTM F436 HARDENED STEEL WASHERS.
- 3. ALL CONNECTIONS NOT FULLY DETAILED ON THESE PLANS SHALL BE DETAILED BY THE STEEL FABRICATOR IN ACCORDANCE WITH AISC SPECIFICATIONS AND MANUAL OF STEEL CONSTRUCTION, 14TH EDITION.
- 4. HOLES SHALL NOT BE FLAME CUT THRU STEEL UNLESS APPROVED BY THE ENGINEER.
- 5. HOT-DIP GALVANIZE ALL ITEMS UNLESS OTHERWISE NOTED, AFTER FABRICATION WHERE PRACTICABLE. GALVANIZING: ASTM A123, ASTM, A153/A153M OR ASTM A653/A653M, G90, AS APPLICABLE.
- REPAIR DAMAGED SURFACES WITH GALVANIZING REPAIR METHOD AND PAINT CONFORMING TO ASTM A780 OR BY APPLICATION OF STICK OR THICK PASTE MATERIAL SPECIFICALLY DESIGNED FOR REPAIR OF GALVANIZING, CLEAN AREAS TO BE REPAIRED AND REMOVE SLAG FROM WELDS. HEAT SURFACES TO WHICH STICK OR PASTE MATERIAL IS APPLIED, WITH A TORCH TO A TEMPERATURE SUFFICIENT TO MELT THE METALLICS IN STICK OR PASTED; SPREAD MOLTEN MATERIAL UNIFORMLY OVER SURFACES TO BE COATED AND WIPE OFF EXCESS MATERIAL.
- 7. A NUT LOCKING DEVICE SHALL BE INSTALLED ON ALL PROPOSED AND/OR REPLACED BOLTS.
- 8. ALL PROPOSED AND/OR REPLACED BOLTS SHALL BE OF SUFFICIENT LENGTH TO EXCLUDE THE THREADS FROM THE SHEAR PLANE.
- ALL PROPOSED AND/OR REPLACED BOLTS SHALL BE OF SUFFICIENT LENGTH SUCH THAT THE END OF THE BOLT BE AT LEAST FLUSH WITH THE FACE OF THE NUT. IT IS NOT PERMITTED FOR THE BOLT END TO BE BELOW THE FACE OF THE NUT AFTER TIGHTENING IS COMPLETED.
- 10. ALL ASSEMBLY BOLTS ARE TO BE TIGHTENED TO A "SNUG TIGHT" CONDITION AS DEFINED IN SECTION 8.1 OF THE AISC, "SPECIFICATION FOR STRUCTURAL JOINTS USING ASTM A325 OR A490 BOLTS", **DATED JUNE 30, 2004.**
- 11. FLAT WASHERS ARE TO BE INSTALLED WITH BOLTS OVER SLOTTED HOLES.
- 12. DO NOT OVER TORQUE ASSEMBLY BOLTS. GALVANIZING ON BOLTS, NUTS, AND STEEL PARTS ; MAY ACT AS A LUBRICANT, THUS OVER TIGHTENING MAY OCCUR AND MAY CAUSE BOLTS TO CRACK AND SNAP OFF.
- 13. PAL NUTS ARE TO BE INSTALLED AFTER NUTS ARE TIGHT AND WITH EDGE LIP OUT. PAL NUTS ARE NOT REQUIRED WHEN SELF-LOCKING NUTS ARE PROVIDED.
- 14. GALVANIZED ASTM A325 BOLTS SHALL NOT BE REUSED.
- 15. WELDING SHALL BE PERFORMED IN ACCORDANCE WITH AMERICAN WELDING SOCIETY (AWS) D1.1-2010 STRUCTURAL WELDING CODE - STEEL.

NOXIOUS WEED PLAN:

THE FOLLOWING ACTIONS WILL BE TAKEN BY THE APPLICANT TO COMPLY WITH THE MONTANA COUNTY NOXIOUS WEED CONTROL ACT.

- ALE HEAVY EQUIPMENT USED DURING CONSTRUCTION WILL BE WASHED BEFORE DEPARTURE FROM THE EQUIPMENT STORAGE FACILITY TO ENSURE THAT WEED SEED FROM DIFFERENT REGIONS ARE NOT TRANSPORTED ONTO THE HOST PROPERTY.
- ATLAS IS RESPONSIBLE FOR WEED CONTROL ON THEIR OWN INDIVIDUAL LOTS AS STATED IN THE MONTANA COUNTY NOXIOUS WEED CONTROL ACT (7-22-2116) AND ACCORDING TO THE GALLATIN COUNTY WEED CONTROL DISTRICT'S NOXIOUS WEED MANAGEMENT PLAN.
- APPROXIMATELY 2,500 SQUARE FEET OF GROUND WILL BE DISTURBED FOR THE CONSTRUCTION OF THIS PROJECT. WITHIN THE ATLAS FENCED COMPOUND, GEOTEXTILE FABRIC WILL BE LAID UNDER A 4" LAYER OF GRAVEL TO PREVENT WEED GROWTH WITHIN THE COMPOUND. IF WEEDS GROW INSIDE THE COMPOUND, ATLAS WILL NOTIFY THE CONSTRUCTION MANAGER TO GET A CONTRACTOR OUT TO THE AREA TO ASSESS AND CORRECT THE SITUATION. WEEDS OUTSIDE OF THE COMPOUND WILL BE WORKED OUT BETWEEN THE LANDOWNER AND ATLAS.
- IF CONSTRUCTION OF THE SITE RESULTS IN THE PROPOGATION OF NOXIOUS WEEDS, THE APPLICANT WILL TREAT NOXIOUS WEEDS USING METHODS APPROVED BY THE COUNTY WEED COORDINATOR.

PROJECT INFORMATION:

BRIDGER SKI HILL

XXX BRIDGER BOWL RD BOZEMAN, MT 59715 (GALLATIN COUNTY)

PLANS PREPARED FOR:



OFFICE: (303) 448-8896


PLANS PREPARED FOR:

4450 ARAPAHOE AVE, SUITE 100 BOULDER, CO 80303 OFFICE: (303) 448-8896



TOWER ENGINEERING PROFESSIONALS

5545 W, 56TH AVE., UNIT E ARVADA, CO 80002 OFFICE: (303) 566-9914 www.tepgroup.net

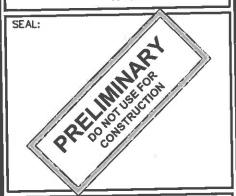

REV	DATE	ISSUED FOR:
0	03-01-16	ZONING
	03-03-16	ZONING
2	03-04-16	ZONING
3	03-29-16	ZONING
3	03-29-16	ZONING

DRAWN BY: CJV CHECKED BY:


SHEET TITLE:


GENERAL NOTES


SHEET NUMBER: **N**='


REVISION: 3


TEP#: 31780.7028

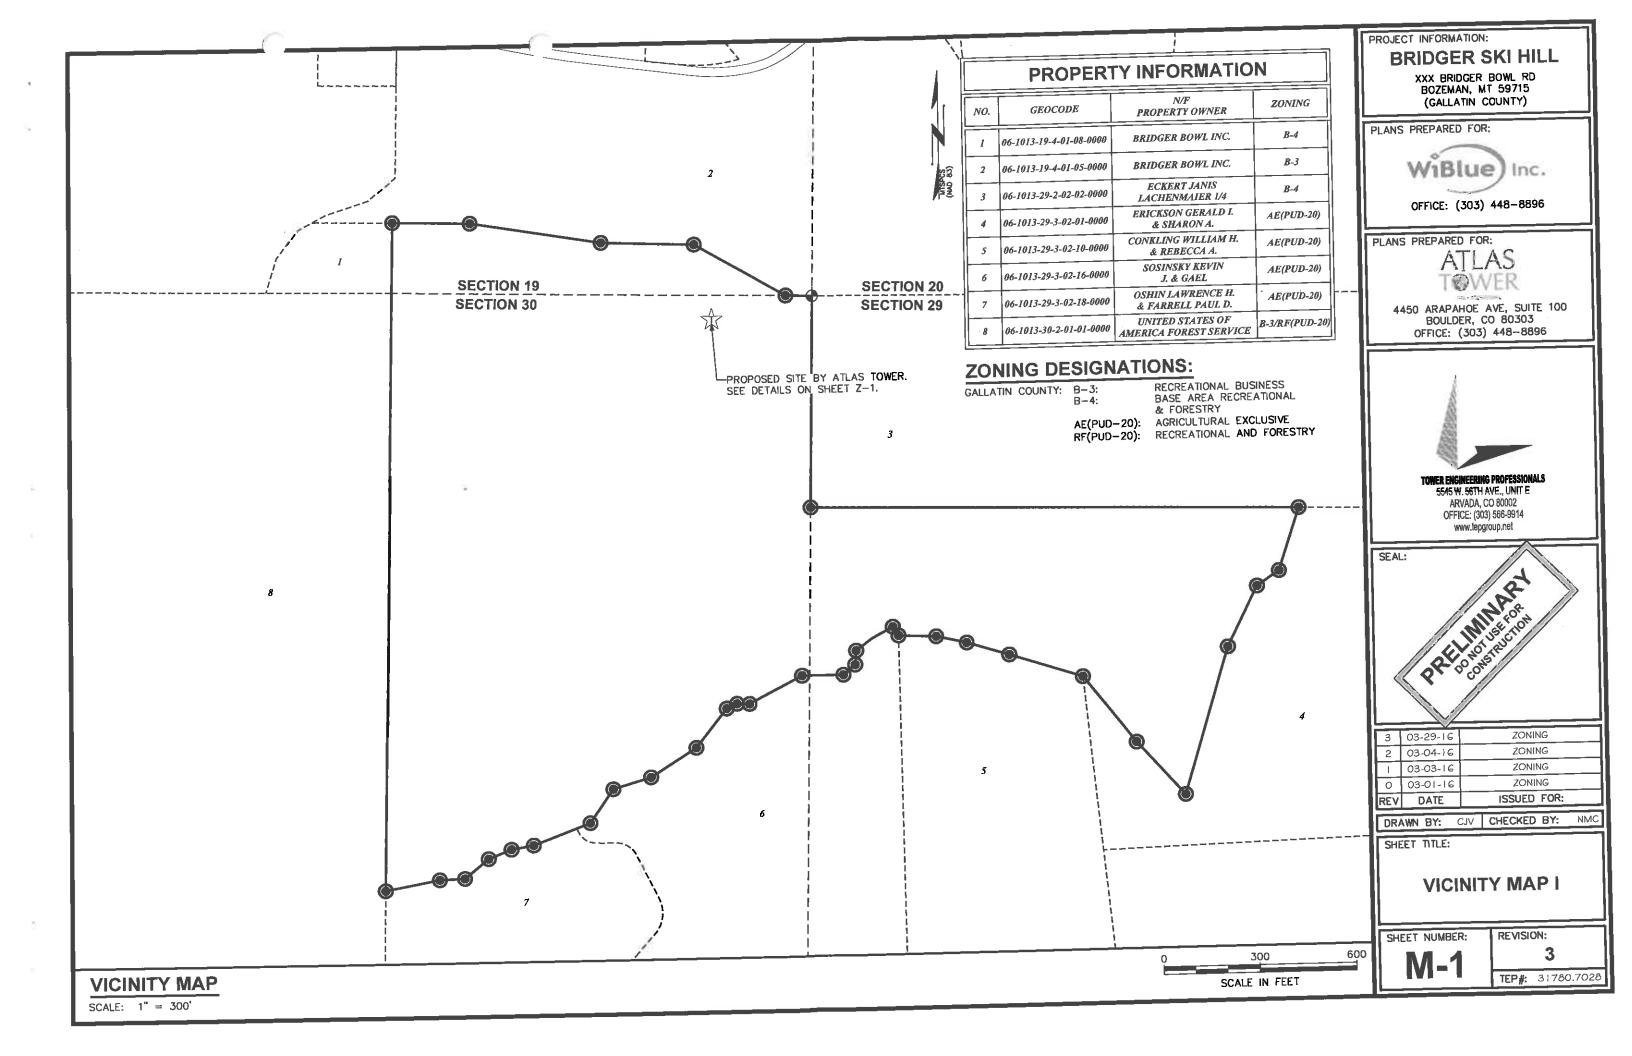

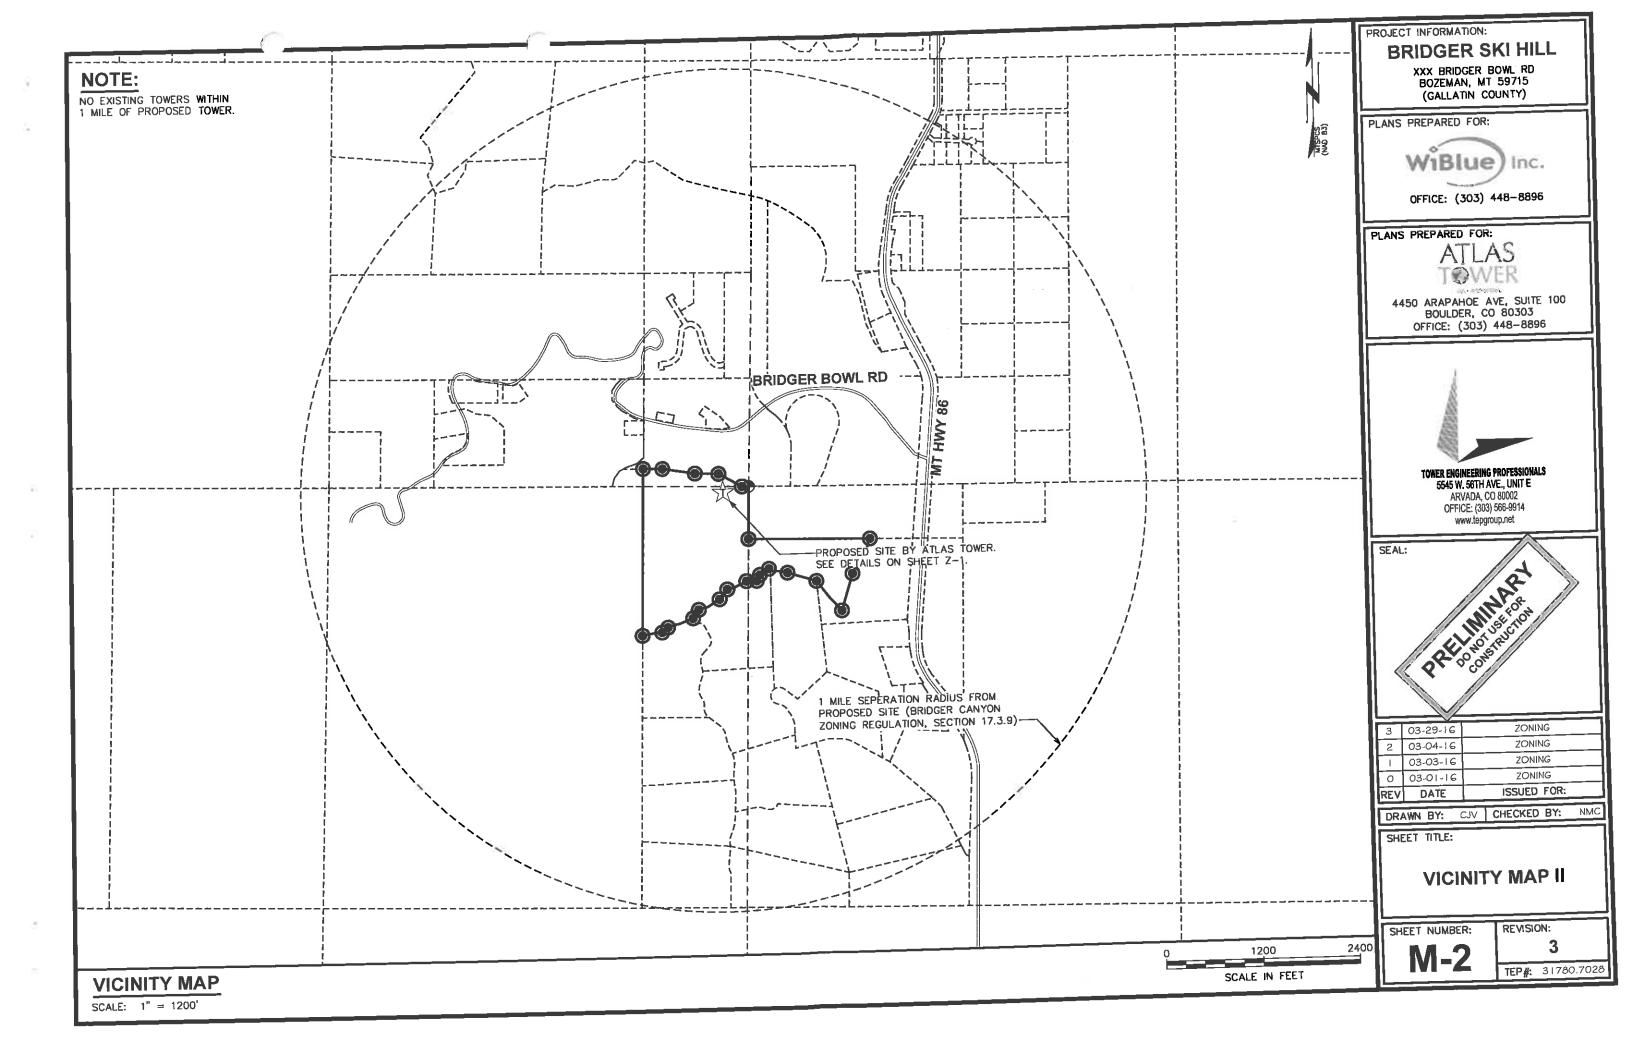

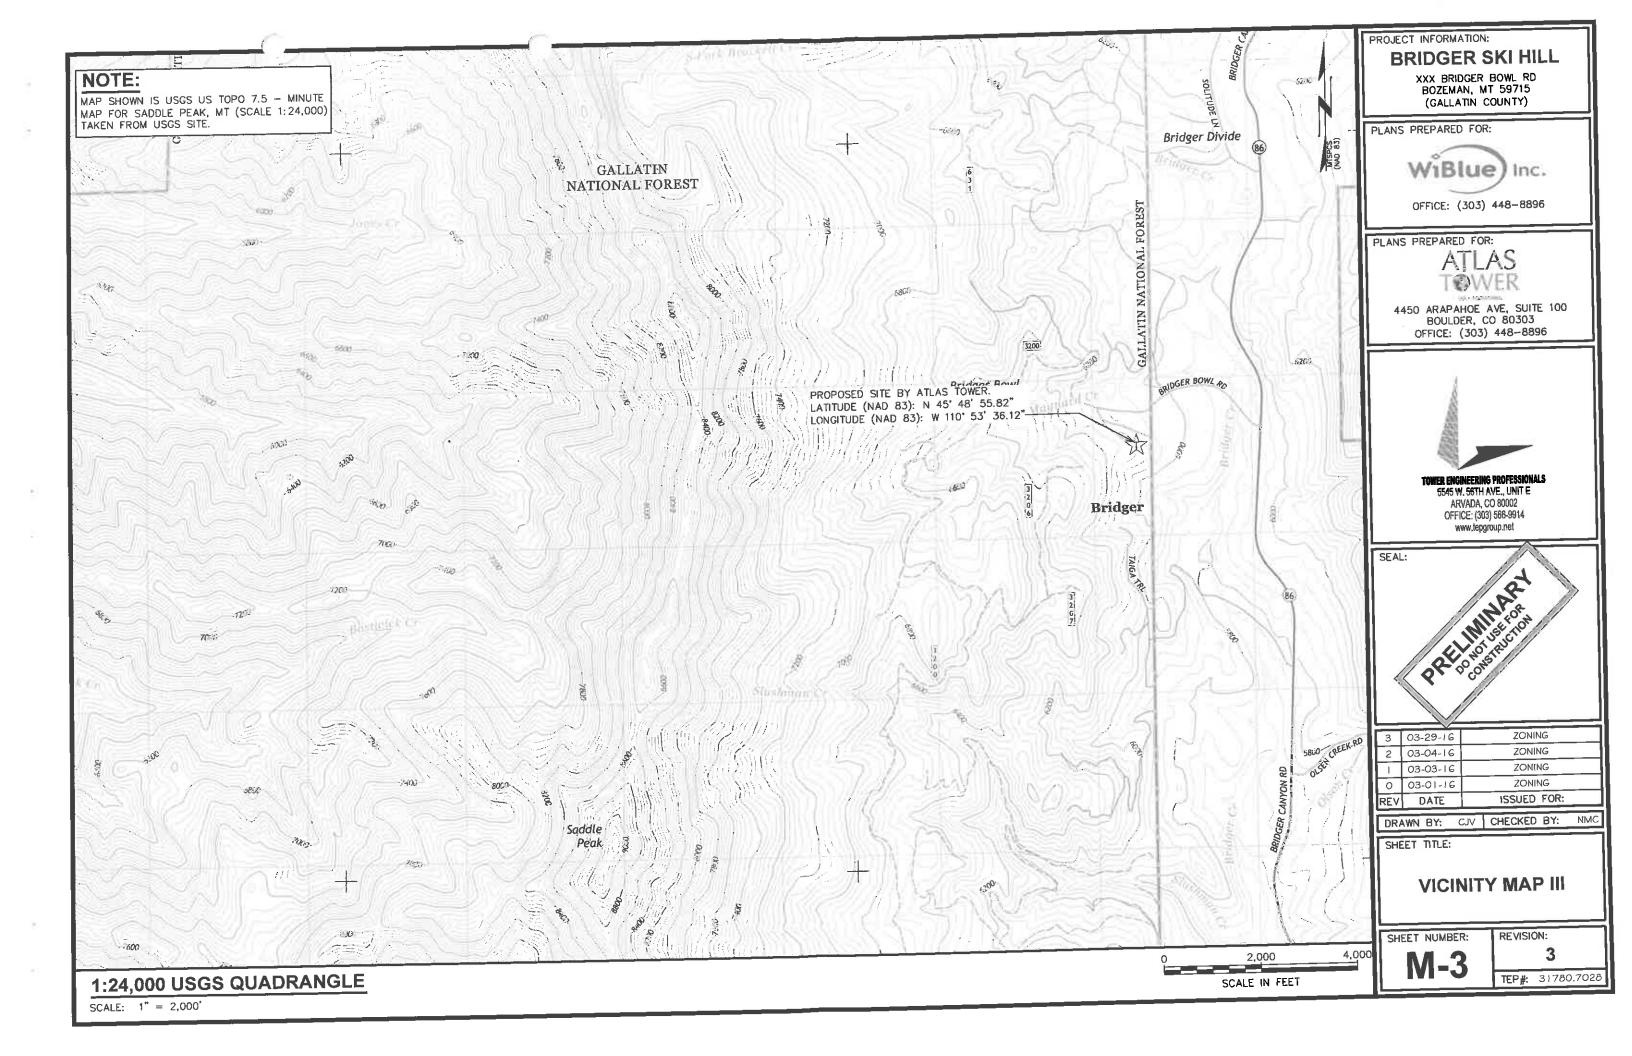

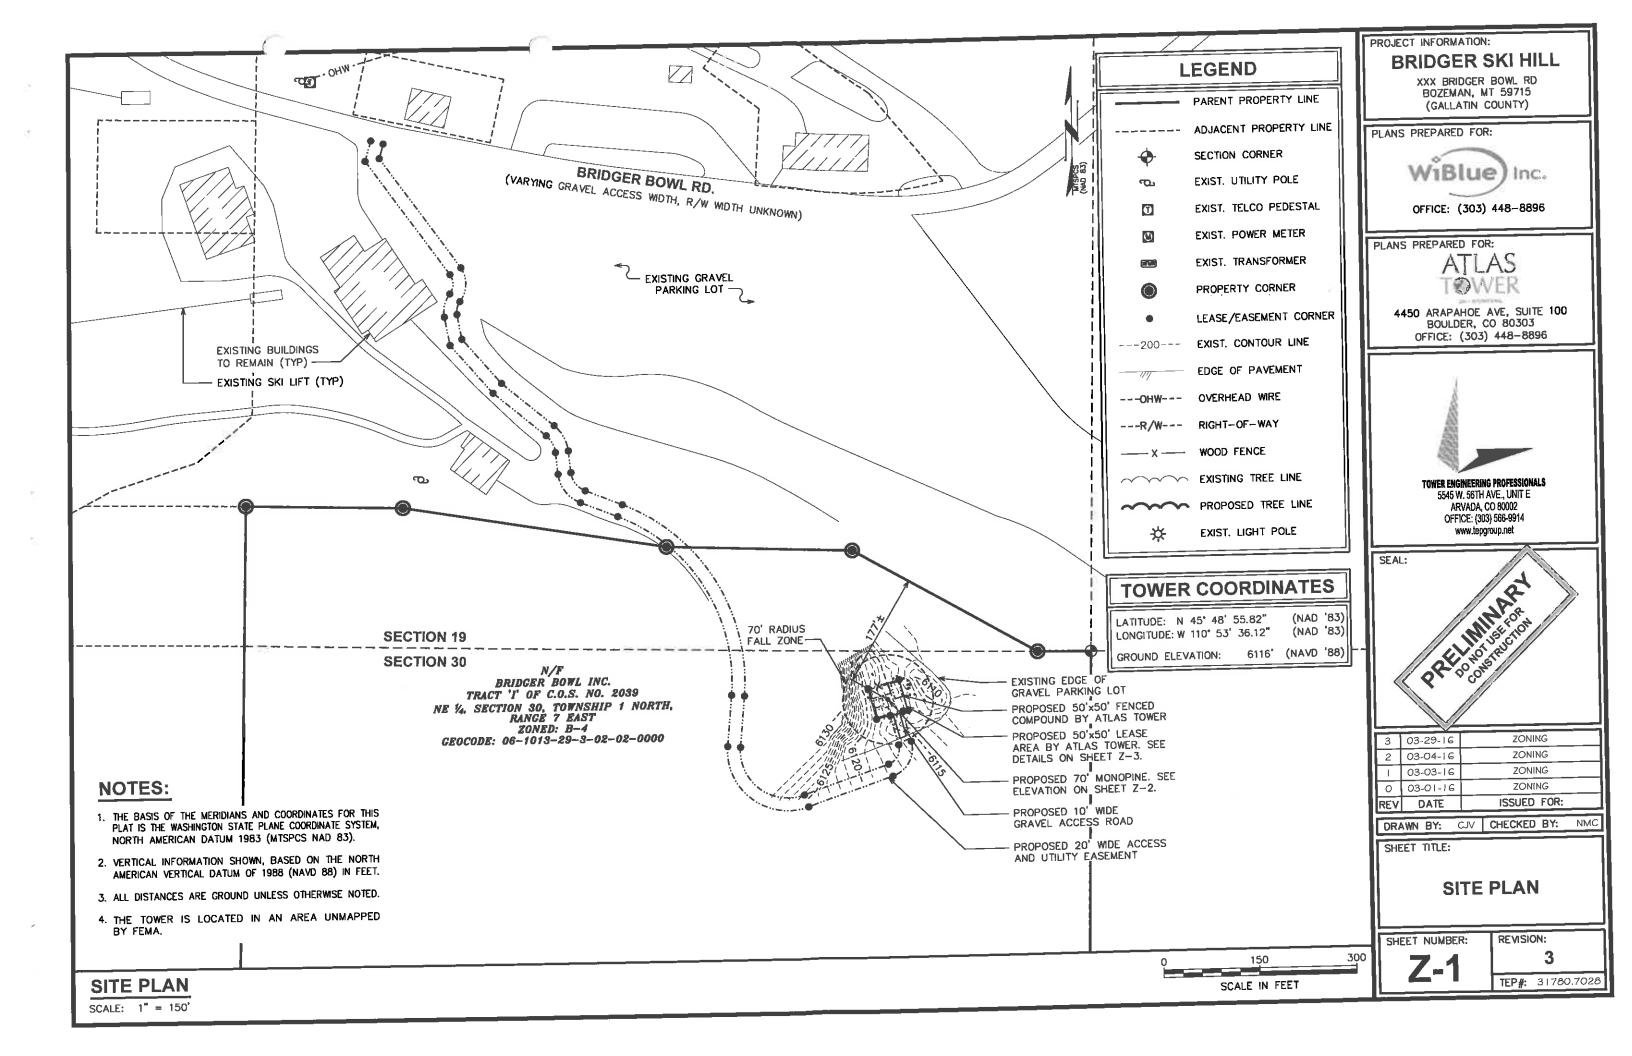

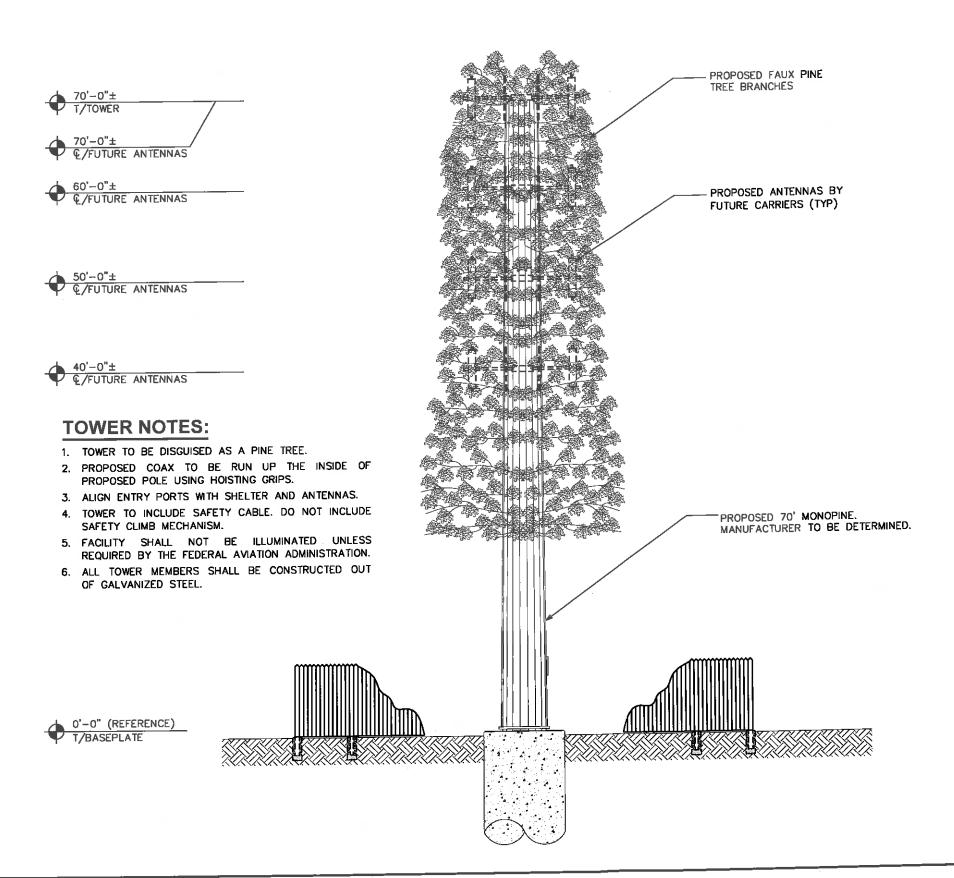

PROJECT INFORMATION:

BRIDGER SKI HILL

XXX BRIDGER BOWL RD BOZEMAN, MT 59715 (GALLATIN COUNTY)

PLANS PREPARED FOR:



OFFICE: (303) 448-8896


PLANS PREPARED FOR:



4450 ARAPAHOE AVE, SUITE 100 BOULDER, CO 80303 OFFICE: (303) 448-8896



TOWER ENGINEERING PROFESSIONALS 5545 W. 56TH AVE., UNIT E ARVADA, CO 80002 OFFICE: (303) 566-9914 www.tepgroup.net

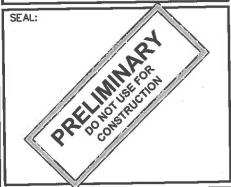

	REV	DATE	ISSUED FOR:
1	0	03-01-16	ZONING
ŀ	1	03-03-16	ZONING
ľ	2	03-04-16	ZONING
	3	03-29-16	ZONING
Ш			

CHECKED BY: NMC DRAWN BY: CJV

SHEET TITLE:

TOWER ELEVATION


SHEET NUMBER:

SCALE IN FEET

REVISION: TEP#: 31780.7028

TOWER ELEVATION

SCALE: $\frac{3}{32}$ " = 1'-0"

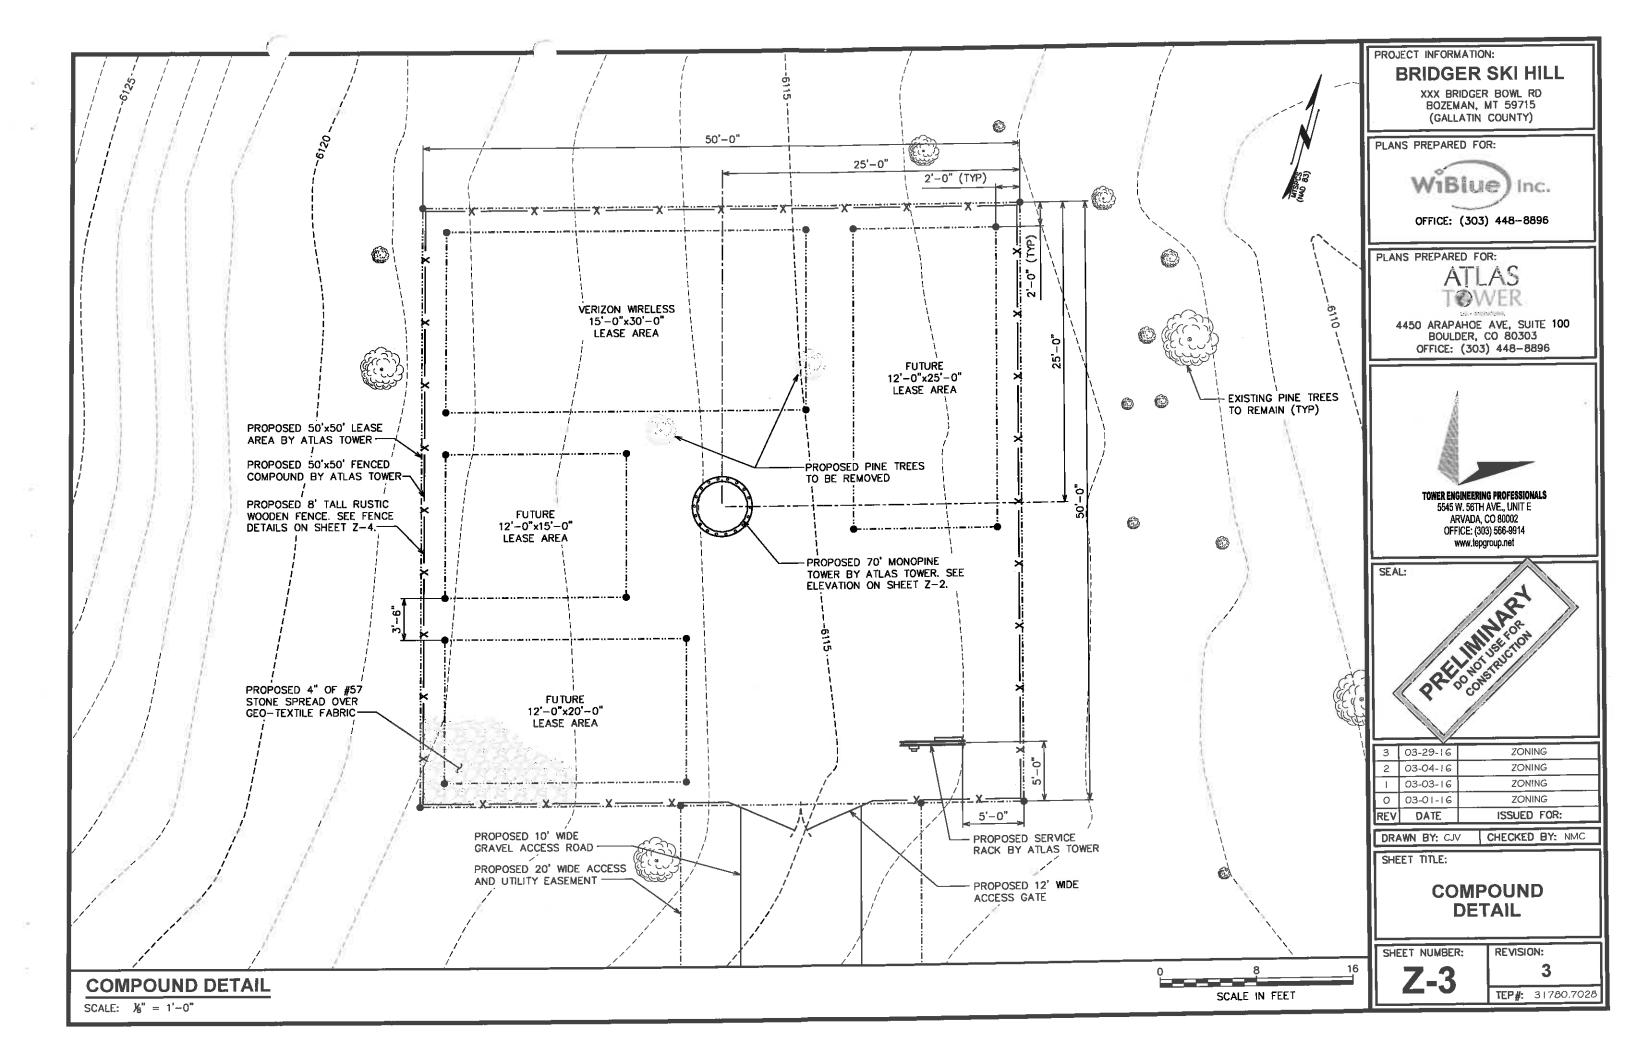


FENCE NOTE:


FENCE TO BE MAINTAINED BY ATLAS TOWER.
ONLY TREATED LUMBER AND HOT DIPPED
GALVANIZED STEEL SCREWS ARE TO BE USED.

DRAWING NOTES:


- 1x6 TREATED WOOD. ATTACH TO 2x4'S WITH HOT DIPPED GALVANIZED STEEL SCREWS.
- 2) 2x4 TREATED WOOD. ATTACH TO GALVANIZED FENCE POST WITH SUPPORT BRACKET AND %" x 1" LAG BOLT (TYP.)
- (3) GALVANIZED FENCE POST
- WOOD FENCE TO BE APPROPRIATELY STAINED OR PAINTED.

8' HIGH FENCE	FOOTINGS
LINE POST - 2" O.D.	9" X 66"
CORNER POST - 3" O.D.	12" X 66"
DRIVEWAY GATE POST - 4" O.D.	18" X 66"
WALKWAY GATE POST - 3" O.D.	12" X 66"

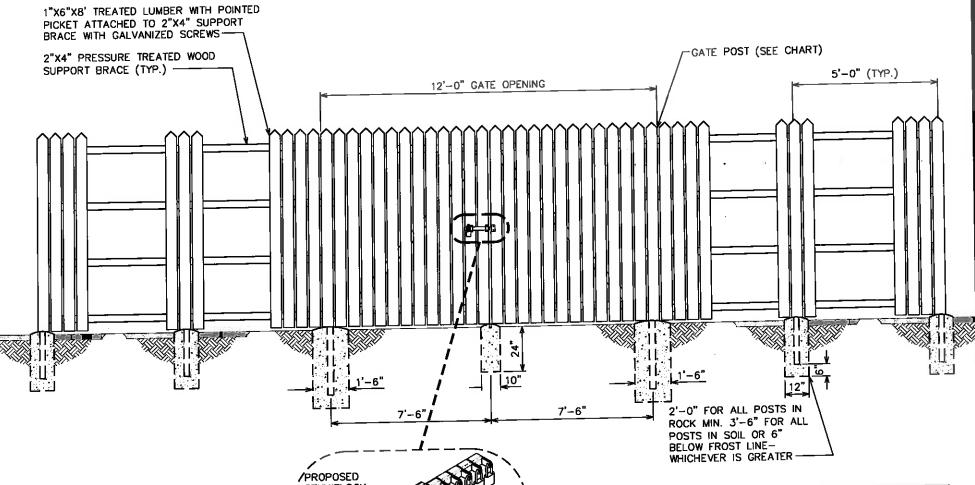


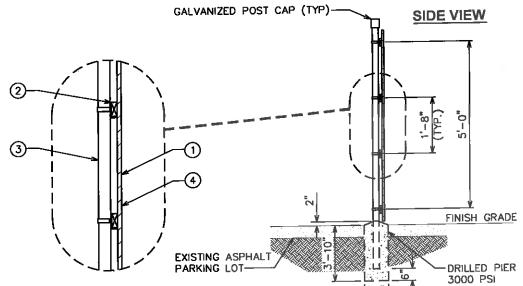

CONCRETE

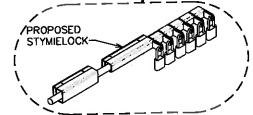

GATE DETENT DETAIL

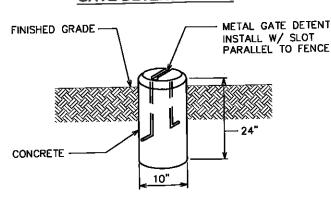

WOODEN FENCE ATTACHMENT BRACKET

LINE POST - 2" O.D.	2"ø ATTACH. BRACKET
CORNER POST - 3" O.D.	3"ø ATTACH. BRACKET
DRIVEWAY GATE POST - 4" O. D.	4"ø ATTACH, BRACKET

NOTE:

GALLATIN COUNTY FROST LINE AT 5'-0" BELOW GRADE.

PROJECT INFORMATION:

BRIDGER SKI HILL

XXX BRIDGER BOWL RD BOZEMAN, MT 59715 (GALLATIN COUNTY)

PLANS PREPARED FOR:



OFFICE: (303) 448-8896

PLANS PREPARED FOR:



4450 ARAPAHOE AVE, SUITE 100 BOULDER, CO 80303 OFFICE: (303) 448-8896



TOWER ENGINEERING PROFESSIONALS

5545 W. 56TH AVE., UNIT E ARVADA, CO 80002 OFFICE: (303) 566-9914 www.tepgroup.net



REV	DATE	ISSUED FOR:
0	03-01-16	ZONING
T	03-03-16	ZONING
2	03-04-16	ZONING
3	03-29-16	ZONING

DRAWN BY: CJV CHECKED BY: NMC

SHEET TITLE:

FENCE DETAILS

SHEET NUMBER:

Z-4

REVISION: 3
TEP#: 31780.7028

TYPICAL FENCE ELEVATION

SCALE: N.T.S.